


Existing Coniferous Tree to be Removed

Existing Hedge to be Removed


Existing Deciduous Tree to Remain and be Protected

Existing Deciduous Tree (dead)

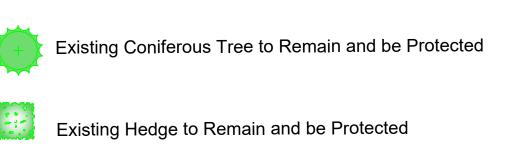

Proposed Replacement Tree (per site plan/landscape plan by others)

Accumulative, total amount of encroachment for each mTPZ in square metres (0.0 m²)

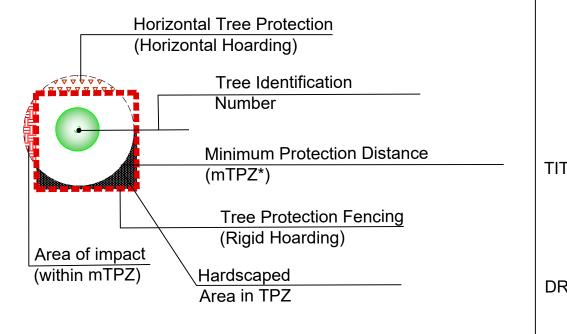

Ryan Atkinson
80 Jutland Rd. Suite 500
Toronto, ON M8Z 2H1

Tree Preservation Plan 1444-1448 Cawthra Rd

SHEET:

1 of 3

DRAWING NO.: SCALE: 1:200

CONTRACT NO.:

• All base information has been supplied by the client.

All field data have been recorded by Michael Petryk, ISA Certified Arborists® # ON-1691-A. All tree locations are based on the survey supplied by the client and field observation by the arborist.

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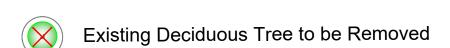
Refer to the Arborist Report prepared for this project for specific instruction regarding tree protection requirements.

No.	DATE	BY	REVISIONS
1	3/01/2018	MBP	Tree Protection Plan
2	5/10/2018	MBP	TPP-Client updates
3	10/02/2018	MBP	TPP-Convert to ARCH D
4	12/16/2019	JCS	Site Plan Updates



enoitsviesdO	EAB-	EAB- EAB-	Hydro; Blackknot	Hydro	ATTENDED TO	EAB Other Stem; 24	S	EAB FAB	EAB	EAB	Broken Limbs, cavity, suckers	Suppressed	Suppressed Deadwood	Hyrdro; suppressed	EAB	EAB				EAB Leaning; Other Stems; 10, 10, 10	EAB	EAB Cavity	EAB	EAB		enoitsvie ed0	Leaning, Other Stems; 18, 14, 14, 12	Leaning; Other Stems; 28 Broken/Cracked limbs;	EAB Other Stems: 22	Other Stems; 14, 12, 12			Other Stems: 10 Other Stems: 18; Growing in fence	Other Stems: 22; Growing in fence		Other Stems:20				Wound	5 5	Wound	Hydro	Against foundation
Upper canopy Pruning (Y/N)						i i					>				>										(N/Y) gainung v	Пррег сапору		>			>		10 11									>		-13 -17
(N\Y) IsvomeЯ	*		*	* *	3	* *	٨	» ×		> >					*	*	* .	* *	*	> >	*	> >	*	> > >	. (N/Y) Isvoma9	> >	× × .	> > :	> > >														×
Construction Impact (None, Low, Medium, High)											>	> 3	>	*	*											Construction Low, Medium Hoarding Req		>			>	* *	> >	> > >	> > >	> >	> >	* *	* *	> >	> > :	·	> >	
Construction inside Min TPZ																									ZqT niM əbizni																			
(m) Tree Height (m)	12	14	10	5	18	11 118	17	17	17	17	18	ω .	ی م	18	18	10	15	9	14	8 8	و	12 12	9	9 11 5	; (u	n) theight (n	1 1	13 10 10	# # #	1 1 8	11 12 11	0 0	w w	8 01 0	9 9 9	3 9 9	1 2 2	10 01	10	10	01 01 5	18 18	14	9 12
Crown Width (m)	9	9 11	4	ω ω	15	4 %	9	9 4	4	4	15	m r	s 4	6	8	4	10	2	4	v v	9	w ∞	9	9 9 1	(w)	Crown Width	N N						ευ 4	4 4	4 4	1 4 4	1 4 4	4 4	4 4	4	4 4	18 6	7	εα 10
(%) poompead	80	100	20	0	10	100	100	95 55	100	100	15	0	10	10	10	90	2	100	15	30	5	5 15	100	20 0	(Deadwood (%	01	10 10 20	100	100		2 S	- 1					100			0 0	10	5	0 0
Live Crown Ratio (%)	10	20	40	80	9	15	0	0 0	0	0 0	9	70	9	20	10	10	30	0 0	70	20	100	30	0	50 50	(%) olts	Live Crown R.	20 20	9 4 9	0 0	0 0 4	9 8 8	04	40	9 60	8 8 8	3 8 8	9 9	9 9	9	9	9 9	8 8 9	90 20	02 8
notition Condition	Poor	Poor	Poor	Good	Good	Poor	Dead	Dead	Dead	Dead	Poor	Good	Fair	Page	Fair	Poor	Good	Dead	Fair	Poor	Poor	Poor	Dead	Good	uon	Overall Condi	Fair	Good Fair Poor	Dead	Poor Dead Fair	Good	Good	Fair	paos paos	9009 9009	good Good	Good	Pace	Poop	Fair	Fair 1	Fair	Good	Fair
Structure	Poor	Poor	Poor	Fair Good	Poop	Poor	Dead	Dead	Dead	Dead	Poor	poog	Good	Poop	Fair	Poor	Good	Dead	Fair	Poor	Poor	Poor	Dead	Good	B	Structure	Fair	Good Fair Poor	Dead	Poor Dead Fair	poog	poog	Fair	poog	600d	good Good	Good	poog	poog	Fair	Fair	Fair	Good	Fair
Hisalth	Poor	Poor	Poor	Fair Good	рооб	Poor	Dead	Dead	Dead	Dead	Fair	Good	Fair	Poop	Fair	Poor	P005	Dead	Fair	Poor Poor	Poor	Poor	Dead	Good		Health	Fair	Good Fair Poor	Dead	Poor Dead Fair	poog good	poog	Fair	poog good	poog 9	900g	poog goog	poog	poog	Fair	Fair .	Fair	Good	Fair
(m) eonstaid noitoetor9 muminiM 💥	2.4	3.0	2.4	3.0	4.2	3.6	3.0	2.4	2.4	2.4	15.0	2.4	2.4	3.0	3.6	2.4	3.0	2.4	2.4	2.4	2.4	3.0	2.4	2.4		Toronto Minin Protection Dis	2.4	2.4	2.4	3.6	3.0	2.4	2.4	1.8	2,4	2.4	2.4	2.4	2.4	2.4	2.4	14.0	5.4	2.4
Tree Category	5. City Ov 1. Private	 Private Private 	5. City Ov	5. City Ov 1. Private	1. Private	1. Private	1. Private	1. Private	1. Private 1. Private	1. Private	1. Private 2. Neighb	2. Neighb	2. Neighb 5. City Ov	1. Private	1. Private	1. Private	1. Private	1. Private	1. Private	1. Private	1. Private	 Private Private 	1. Private	1. Private 1. Private	e	Tree Category	Priv.	1. Private 1. Private 2. Neighb	. Priv.	 Private Private 	1. Private 2. Neighb 7. Neighb	6. Shared	6. Shared 6. Shared	6. Shared 2. Neighb 2. Neighb	2. Neighb 2. Neighb 7 Neighb	2. Neighb 2. Neighb 2. Neighb	2. Neighb	2. Neighb 2. Neighb	2. Neighb 2. Neighb	2. Neighb 2. Neighb	2. Neighb 2. Neighb	2. Neighb 2. Neighb 2. Neighb	2. Neighb 5. City Ov	1.Private 2. Neighb
m 4.f @ (mo) HBd %	26	42	20	32	99	24	45	18	20	18	190	15	16	20	95	20	46	12	22	20	12	32	20	20	ա թ.	DBH (cm) 🚳 1	36	16 26 190	26	45 56 18	28	12	12 22	8	34	20	18 18	20	18	18	18	180	90	14
leoineto8	Fraxinus americana	Fraxinus americana Fraxinus americana	Prunus pensylvanic	Acer campestre Picea pungens	Acer saccharinum	us american us american	Fraxinus americana	us american	us american	raxinus american	Salix fragilis	Picea glauca	Picea glauca Tilia cordata	Acer saccharinum	Acer saccharinum Fraxinus americana	Fraxinus americana	Acer saccharinum	Fraxinus americana Fraxinus americana	Picea glauca	Fraxinus americana Acer negundo	Fraxinus americana	Fraxinus americana Acer saccharinum	Fraxinus americana	Fraxinus americana Betula papirifera		leoineto8	Acer negundo Acer negundo	gundo alba	Fraxinus pennsylvanica Fraxinus pennsylvanica	Fraxinus pennsylvanica Fraxinus pennsylvanica Acer saccharinum	Acer saccharinum Picea abies	Acer plotanoides Acer plotanoides	Ulmus pumila Acer saccharinum	Acer saccharinum Thuja occidentalis	Thuja occidentalis Thuja occidentalis	Thuja occidentalis Thuia occidentalis	Thuja occidentalis Thuja occidentalis	Thuja occidentalis Thuja occidentalis	Thuja occidentalis Thuja occidentalis	Thuja occidentalis Thuja occidentalis	Thuja occidentalis Thuja occidentalis	Acer saccharinum Acer rubrum	Acer saccharum Acer campestre	Thuja occidentalis Picea abies
Species	White Ash	White Ash White Ash	Pin Cherry	Hedge Maple Colorodo Spruce	Silver Maple	White Ash White Ash	White Ash	White Ash White Ash	White Ash	White Ash	Crack Willow	White Spruce	White Spruce Littleleaf Linden	Silver Maple	Silver Maple White Ash	White Ash	Silver Maple	White Ash White Ash	White Spruce	White Ash Manitoba Maple	White Ash	White Ash Silver Maple	White Ash	White Ash White Birch		(A) 10/20	444	Norway Maple Manitoba Maple Weeping Willow	Green Ash Green Ash	Green Ash Green Ash Silver Maple	Silver Maple Norway Spruce	Norway Maple Norway Maple	Siberian Elm Silver Maple	Silver Maple White Cedar	White Cedar White Cedar	White Cedar White Cedar	White Cedar	White Cedar White Cedar	White Cedar White Cedar	White Cedar White Cedar	White Cedar White Cedar	Silver Maple Red Maple	Sugar maple Hedge Maple	White Cedar Norway Spruce
Tree Map Aumber	2	ю 4	W I	9 /	00	9 01	13	12 13	11	15	17	81 5	20 13	21	22 23	24	25	26	28	30 29	31	33 33	34	35	uper 6	Tree Map Nun	88 68	40 41 42	44	45	84 69 6	51	5. 5.3	55	58	y 8 12	3 29 89	64	99	68 69	70 71	73	75	77

LEGEND



Existing Coniferous Tree to be Removed

Existing Hedge to be Removed

Existing Deciduous Tree to Remain and be Protected

Existing Deciduous Tree (dead)



Existing Coniferous Tree to Remain and be Protected




Existing Hedge to Remain and be Protected



Proposed Replacement Tree (per site plan/landscape plan by others)



Accumulative, total amount of encroachment for each mTPZ in square metres (0.0 m²)

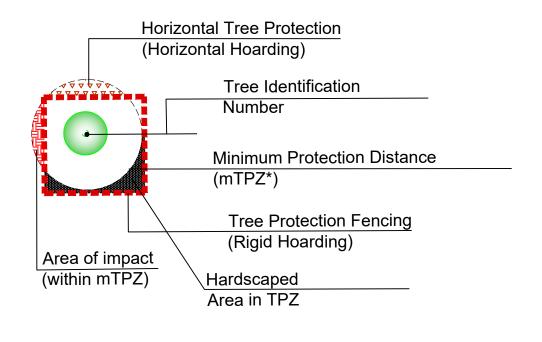

Ryan Atkinson 80 Jutland Rd. Suite 500

Tree Preservation Plan
1444-1448 Cawthra Rd

Toronto, ON M8Z 2H1

DRAWING NO.:

CALE: 1:200

CONTRACT NO.: SHEET:

1 of 3


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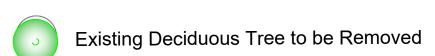
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	4	12/16/2019	JCS	Site Plan Updates
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LEGEND



Existing Coniferous Tree to be Removed

Existing Hedge to be Removed

Existing Deciduous Tree to Remain and be

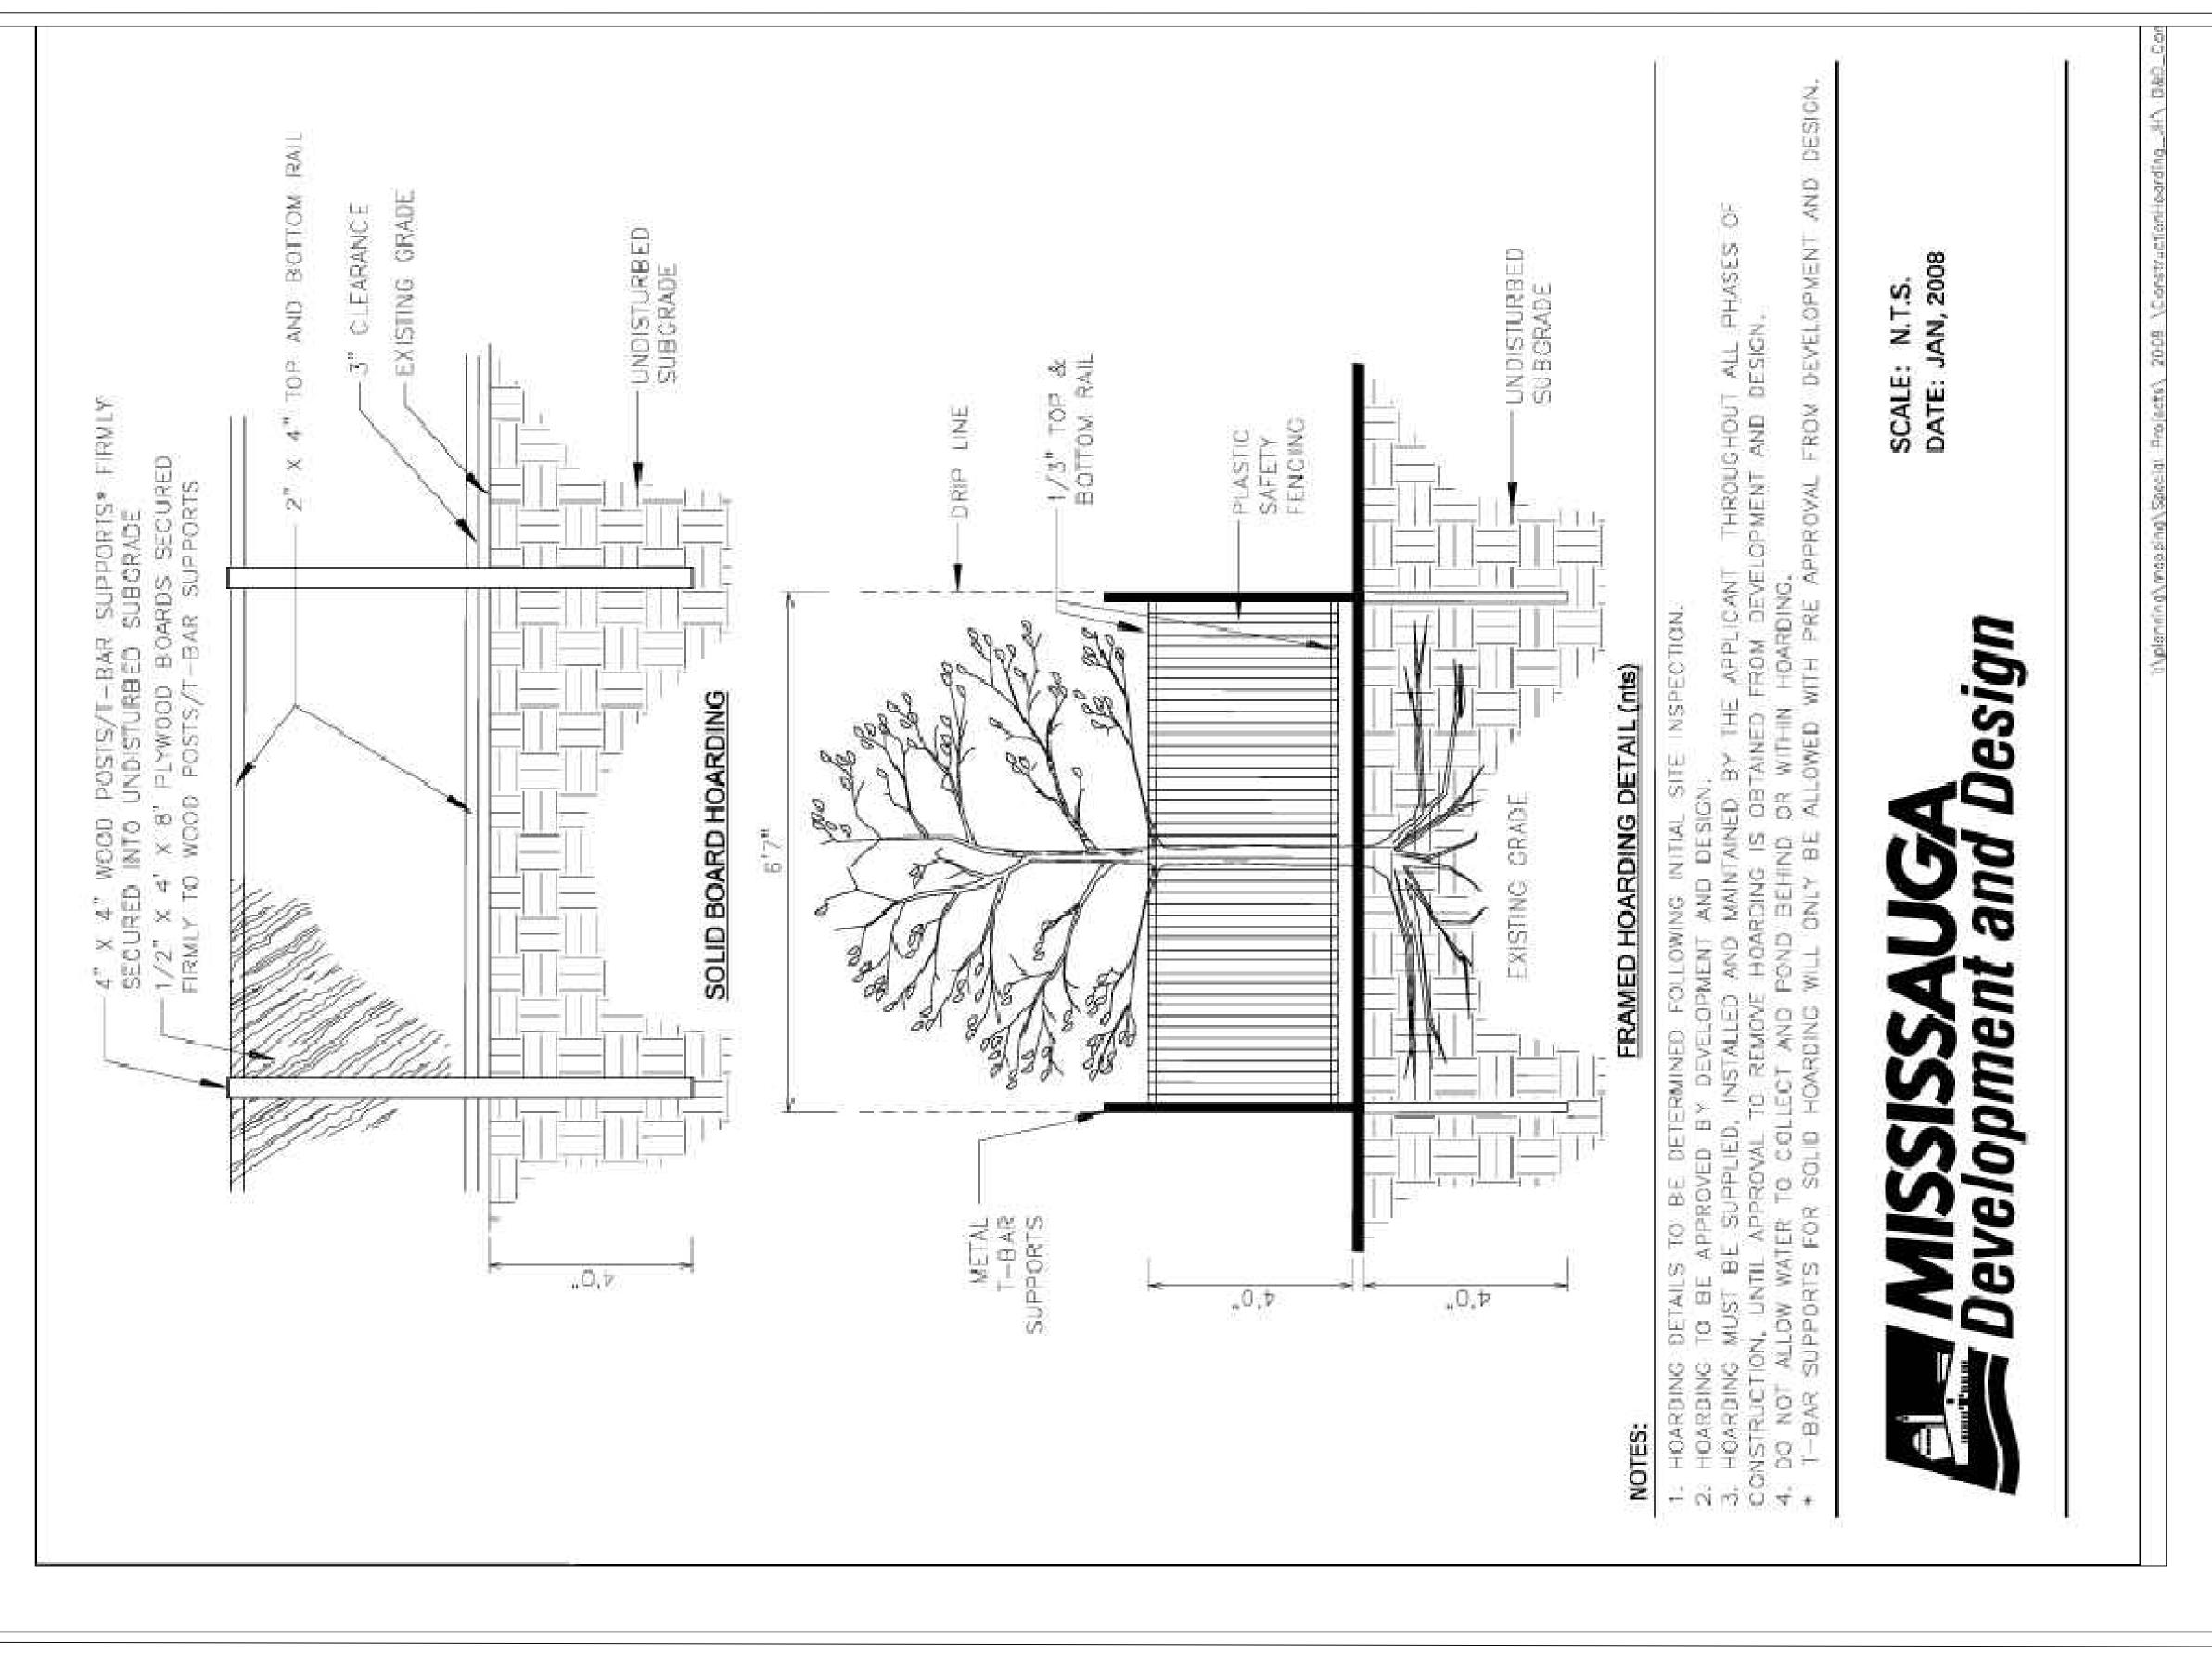Protected

Existing Deciduous Tree to Remain and be

Existing Deciduous Tree (dead)



Existing Coniferous Tree to Remain and be Protected




Existing Hedge to Remain and be Protected



Proposed Replacement Tree (per site plan/landscape plan by others)



Accumulative, total amount of encroachment for each mTPZ in square metres (0.0 m²)

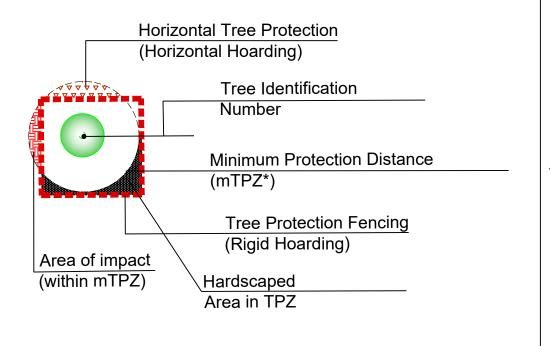

Ryan Atkinson
80 Jutland Rd. Suite 500
Toronto, ON M8Z 2H1

Tree Preservation Plan
1444-1448 Cawthra Rd

DRAWING NO.: TPP - 3

CALE: 1:200

CONTRACT NO.: SHEET: 1 of 3

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